

PROJECT HIGHLIGHTS:

- 1. THIS PROJECT IS TO IMPROVE THE FRONT AND BACK PORCH.
- 2. THE EXISTING PRIMARY STRUCTURE IS 1,319 SF. THE
- EXISTING OUTBUILDING/GARAGE IS 766 SF.

 3. THE EXISTING DRIVEWAY IS ASPHALT.
- 4. NO NEW STRUCTURES.
- 5. NO NEW WATER SERVICES.
- 6. NO NEW SANITARY SEWER LATERALS.
- NO OUTSIDE LIGHTING IMPROVEMENTS.
 TRASH SERVICE WILL BE RESIDENTIAL CURB SIDE. NO DUMPSTER.

SITE SUMMARY TABLE					
LOT SIZE	7,503 SF (0.172 AC)				
EX. ZONING	OTK				
PROP. ZONING	OTK				
PROP. BLDG. USE	OFFICE/ PROF.				
EX. PRIMARY STRUCTURE	1,319 SF 17.6%				
EX. OUTBUILDING/GARAGE	466 SF 6.2%				
PROP. BUILDINGS	0 SF 0.0%				

IMPERVIO	OUS AREA TA	ABLE	
LOT SIZE	7,503 SF	SF	
EXISTING			
EX. HOUSE	1,319	SF	17.6%
EX. GARAGE	766	SF	10.2%
EX. PATIO	15	SF	0.2%
EX. LEADWALK	88	SF	1.2%
EX. REAR WALKWAY	195	SF	2.6%
EX. DRIVEWAY	1,006	SF	13.4%
EX. PORCH	196	SF	2.6%
TOTAL IMPERVIOUS	3,585	SF	47.8%
PROPOSED			
EX. HOUSE	1,319	SF	17.6%
EX. GARAGE	766	SF	10.2%
EX. REAR WALKWAY	76	SF	1.0%
EX. DRIVEWAY	1,006	SF	13.4%
NEW LEADWALK	34	SF	0.5%
NEW PATIO	120	SF	1.6%
NEW REAR WALKWAY	11	SF	0.1%
NEW PORCH	206	SF	2.7%
TOTAL IMPERVIOUS	3,538	SF	47.2%
CHANGE (DECREASE)	(47)	SF	-0.6%


LOT DRAINAGE AREA SUMMARY				
RATIONAL METHOD Q=CiA				
LOT SIZE (A)	7,503 SF (0.172 AC)			
TIME CON. (Tc)	10 MINUTES			
I ₁₀₀ (i)	11.6 IN/HR			
С	0.5			
Q (CFS)	1.00			

!!CAUTION!!
Contractor to Verify
Exact Location &
Depth of Exist
Facilities Prior to any
Construction Activities

1"=10'

<u>CAUTION!!!</u>

CONTACT: wwwtexas811.org for
UTILITY LOCATES PRIOR TO CONSTRUCTION

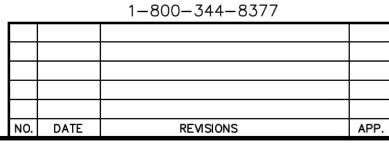

110 TAYLOR ST.

LOT 2-A, BLOCK 11; ORIGINAL TOWNSITE

OF KELLER

CITY OF KELLER, TARRANT CO., TX

SITE LAYOUT PLAN

J. S. Ground Engineering, LLC
4108 Dundee Court (817) 320-5330 ph.
Colleyville, Texas 76034
FIRM REGISTRATION NO. F-1276

SCALE: DGN. BY: J

 SCALE:
 DGN. BY:
 JSG

 DATE:
 JULY 28, 2023
 DWN. BY:
 WJW

 JSGE NO.
 DWG. NO.



J. S. Ground Engineering, L


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SHEET NO.


C2

28-23


PROPOSED SITE

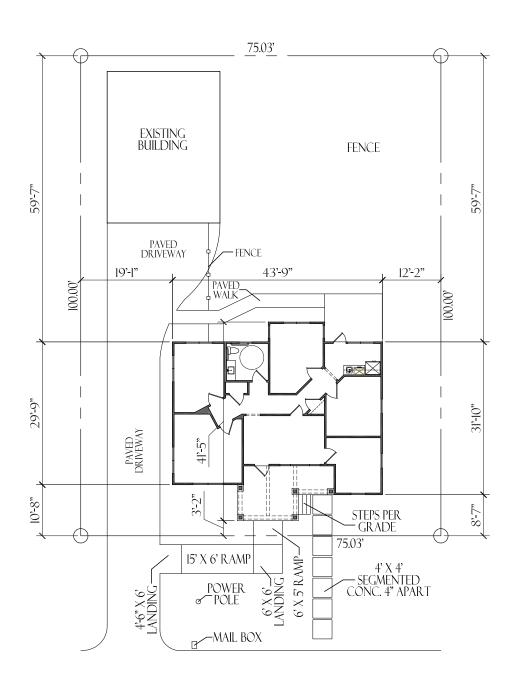

110 TAYLOR STREET

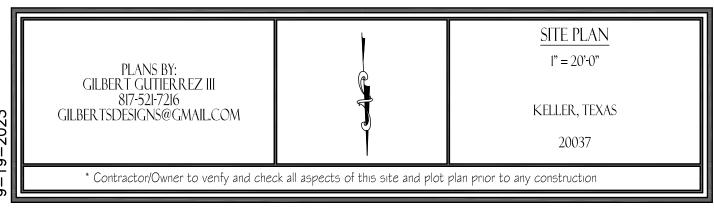

19-2023

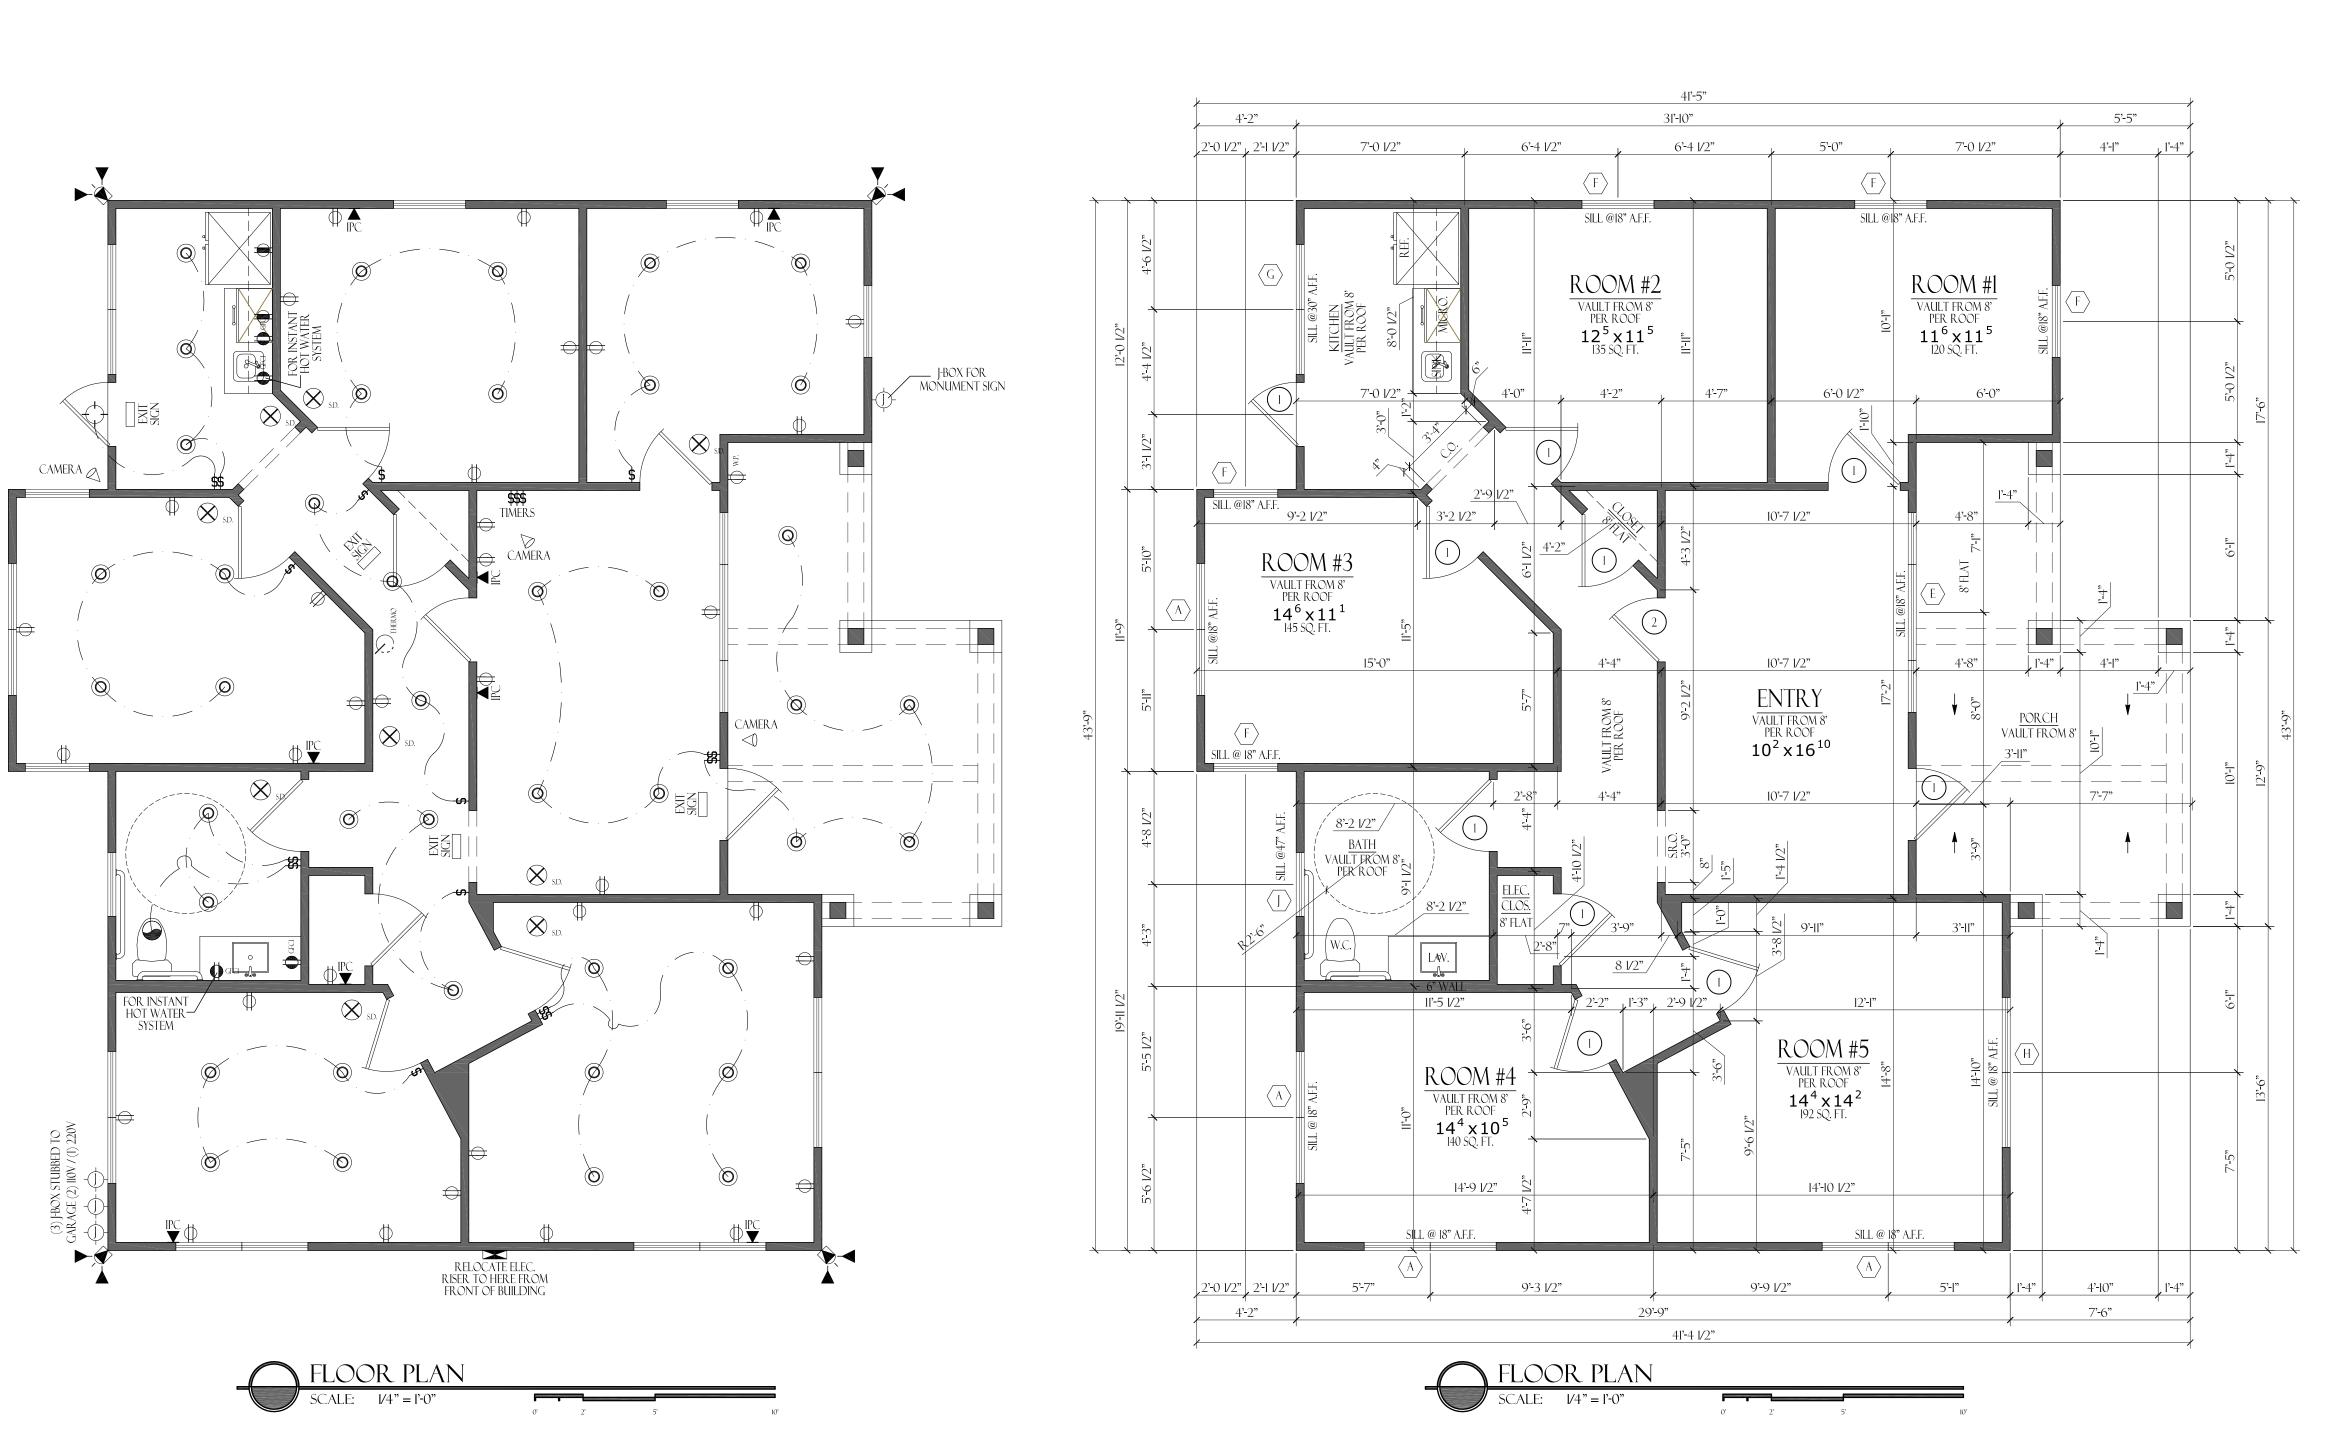

DOOR SCHEDULE

QTY.: MARK: SIZE: REMARK

10: 1: 3 ° 6 8 : S.C.

1: 2: 2 8 6 8 : S.C.

11: TOTAL NEW DOORS

NOTE:WINDOW / DOOR CALL-OUTS ON PLANS SUPERCEDES SCHEDULE. VERIFY PRIOR TO ANY CONSTRUCTION

 QTY.
 MARK
 SIZE
 REMARK

 4
 A
 5 6 5 5 6 TWIN (2) MLD. S.H. D.L.

 1
 E
 8 0 5 0 TRIPLE (3) MLD. FXD. D.L.

 5
 F
 3 0 5 0 S.H. D.L.

 1
 G
 5 4 0 TWIN (2) MLD. FXD. D.L.

 1
 H
 6 3 5 TWIN (2) MLD. S.H. D.L.

 1
 J
 2 8 3 FXD. D.L.

 13
 TOTAL NEW WINDOWS

	ELECTRICAL LEGEND						
	LIGHT FIXTURE	Φ	ONE SOCKET SWITCHED				
0	RECESSED "CAN" LIGHT	•	DEDICATED OUTLET				
©	4" MINI CAN LIGHT	F.P.	FLOOR PLUG				
	CAN DIRECTIONAL LT.	Фср.	CEILING PLUG				
	WALL SCONCE	H	PANEL BOX LOCATION				
	EXHAUST FAN	— <mark>∳</mark> GAS	GAS STUB				
	EXHAUST FAN / LIGHT	H.B.	HOSE BIB				
	OVER / UNDER CAB LIGHT	S.D.	SMOKE DETECTOR				
	TRACK LIGHT	\mathcal{O}	THERMOSTAT				
	FLOURESCENT LIGHT	000	DOOR BELL CHIME				
	CEILING FAN	— □	DOOR BELL BUTTON				
	SWITCHED FLOOD LIGHT		CONDENSOR				
	MOTION FLOOD LIGHT		SATTELITE DISH				
\$	SWITCH	_ _ ▼	ETHERNET DROP				
Φ	IIO OUTLET	P ▼	PHONE DROP				
220	220 OUTLET	<u>C</u> ▼	CABLE DROP				
∮ GFCI	GROUND FAULT OUTLET	^ ▼	ALARM KEYPAD				
₩.P.	WEATHER PROOF OUTLET	SPKR	SPEAKER LOCATION				
*	4 SOCKET OUTLET		UPLIGHT				

PLAN USE AGREEMENT By using these plans builder / owner agrees to the following: These plans are the property of Gilbert Gutierrez. and are not to be reproduced, traced, or reused for construction without the written permission of Gilbert Gutierrez III. These plans are intended to provide the necessary construction information to build this structure. Builder / owner shall verify and check all aspects prior to any construction. Any jobsite changes will void Designers liability. Designers liability not to exceed fee paid for plans. DRAWN BY: ĞĞİİ .9-19-2023 CHECKED BY: FINAL REVIEW BY: CONSTRUCTION BY: Contractor shall verify all dimensions prior to beginning construction and all notify the Designer of any discrepencies immediately. Contractor shall follow all applicable state and local codes / ordinances. All glazing within 2'-0" from jamb of ext. door shall be tempered. Plumbing walls at commodes shall be 2x6 studs. .) All doors on first floor shall be 8' - 0" tall unless noted otherwise. econd floor doors shall be 6' - 8" u.n.o.

6.) Plans shall conform to the 2015 International Building Code, as well as all other applicable and / or governing codes.
7.) All roof penetrations shall be on a side or rear face of the roof.
8.) G.C. is responsible for notifying all subcontractors of changes or revisions to plans / construction drawings.
9.) All second floor plate heights are based on 16" floor system. Actual plate heights may vary. Verify with builder / engineer.

110 TAYLOR STREET

PLANS BY:
GILBERT GUTIERREZ III
817-521-7216
GILBERTSDESIGNS@GMAIL.COM

JOB #:
20037
A-1

1,298 中

185 **Ф**

1,483 中

APPROXIMATE LIVING

APPROXIMATE TOTAL A.U.R.

PORCH

EXISTING AREAS:

APPROXIMATE LIVING 1,298 ©

PORCH 115 ©

APPROXIMATE TOTAL AUR. 1,413 ©

AREAS:

NOTES:

1) ALL DOORS, INTERIOR AND EXTERIOR, TO BE I HOUR FIRE RATED.

2) ALL SHEETROCK, WALLS AND CEILINGS, TO BE 5/8" FIRE RATED SHEETROCK.

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110 TAYLOR STREET

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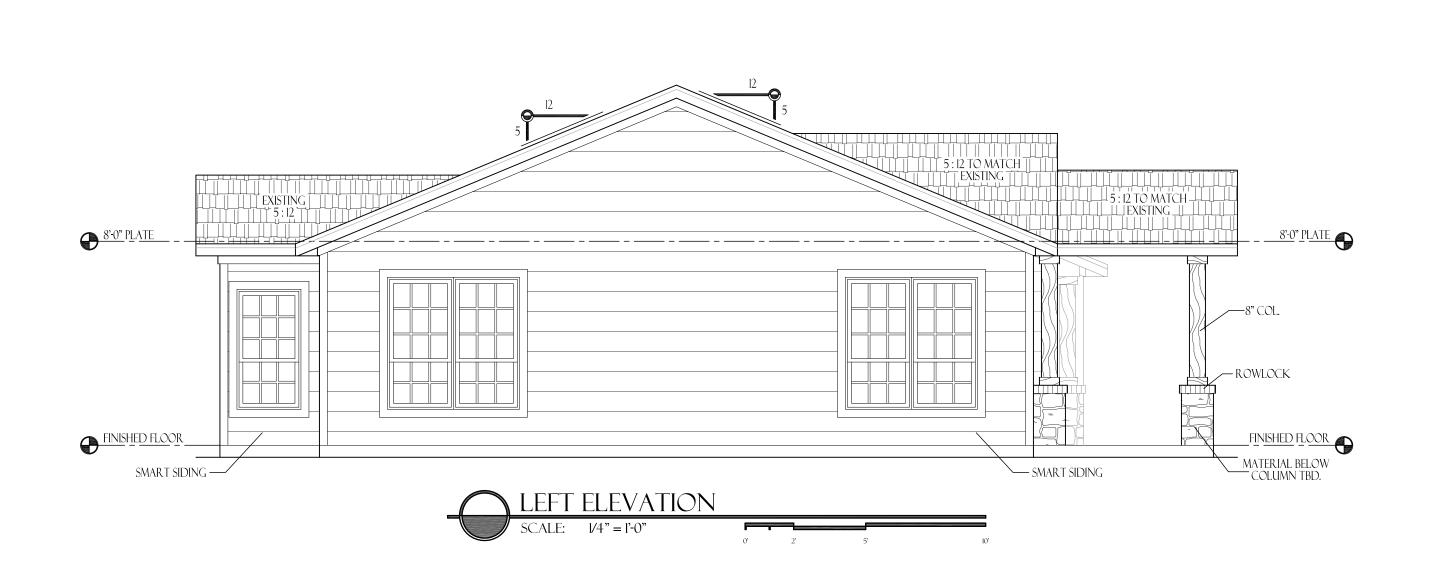
JOB #: 20037

STRAE

MATSON:

SALE 14'-10'

REAR ELEVATION



ROWLOCK—

FRONT ELEVATION

SCALE: 1/4" = 1'-0"

8" COL.—

—— SMART SIDING

__FINISHED FLOOR _

FABRIC AWNING



NOTE:


BUILDER TO VERIFY EXISTING PLATE LINE HEIGHTS AND ROOF PITCH.


_ EXISTING L

SMART SIDING —

FINISHED FLOOR

- FABRIC AWNING -

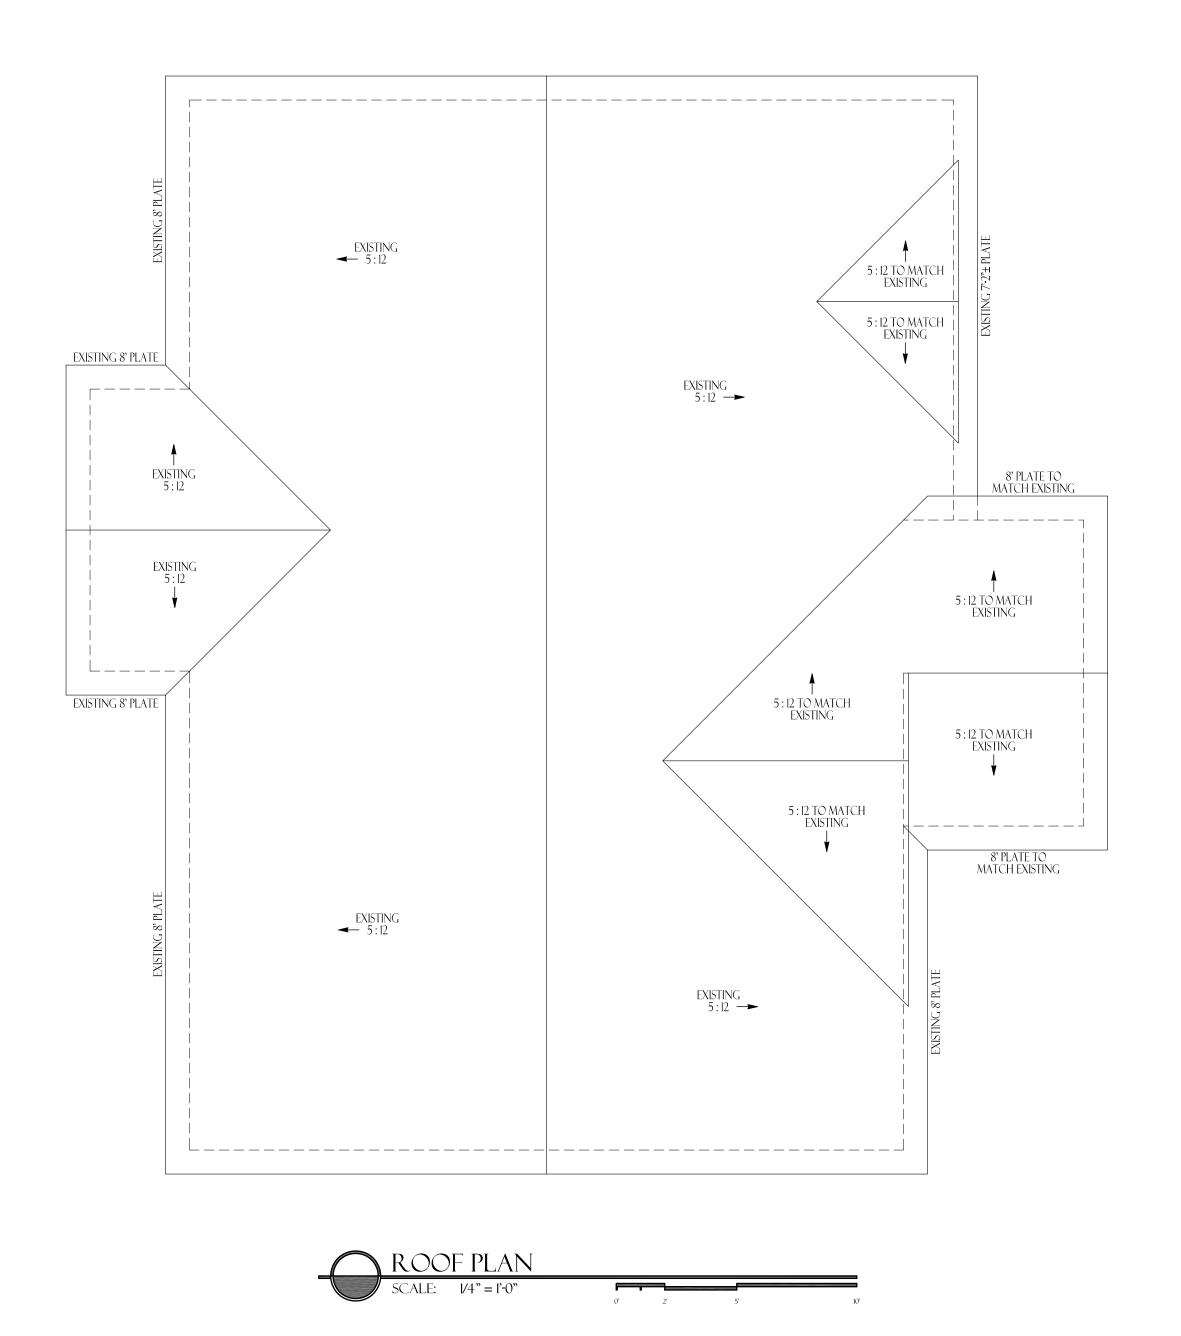

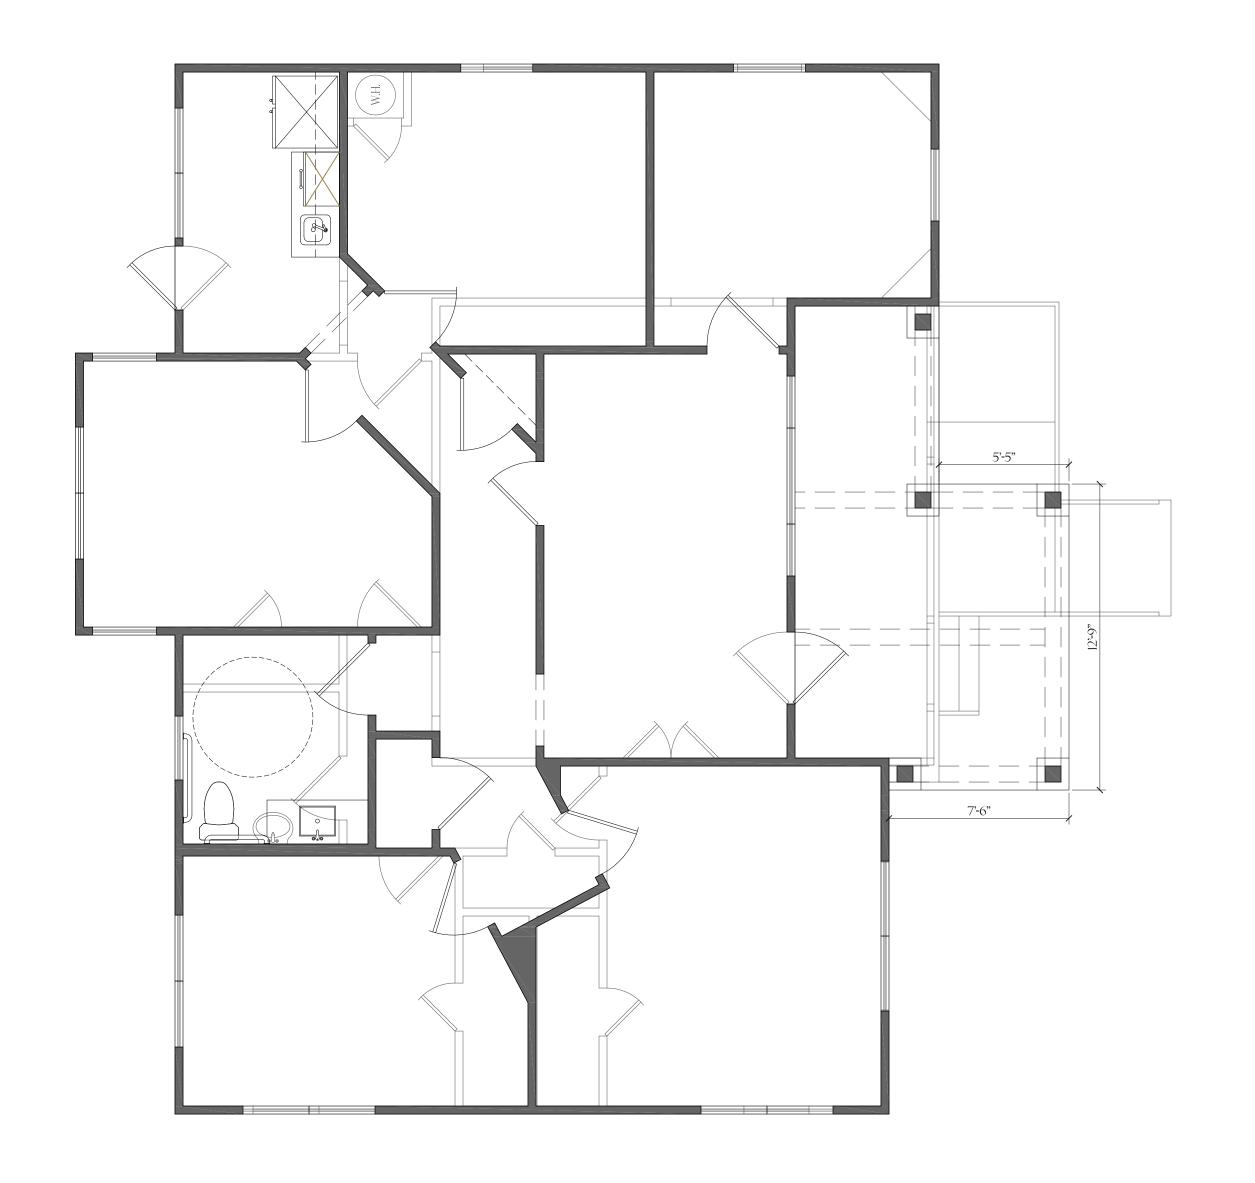

TAYLOR STREET

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All second floor plate heights are based on 16" floor system. Actual

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Plumbing walls at commodes shall be 2x6 studs.

plate heights may vary. Verify with builder / engineer.

GGIII

.9-19-2023...

exceed fee paid for plans.

DRAWN BY:

CHECKED BY:

FINAL REVIEW BY:

CONSTRUCTION BY:

plans / construction drawings.

PLANS BY:
GILBERT GUTTERREZ III
817-521-7216
GILBERTSDESIGNS@GMAIL.COM

JOB #: 20037
A-3

NOTE:

BUILDER TO VERIFY EXISTING PLATE LINE HEIGHTS AND ROOF PITCH.


<u>√</u>5:12 5:1<u>2</u> 8' PLATE _____ 5:12 RAKE **√**5:12 5:<u>12</u> ORIGINAL ROOF PLAN

SCALE: V4" = 1'-0"

0
2
5 ORIGINAL FLOOR PLAN

SCALE: 1/4" = 1'-0"

0
2
5

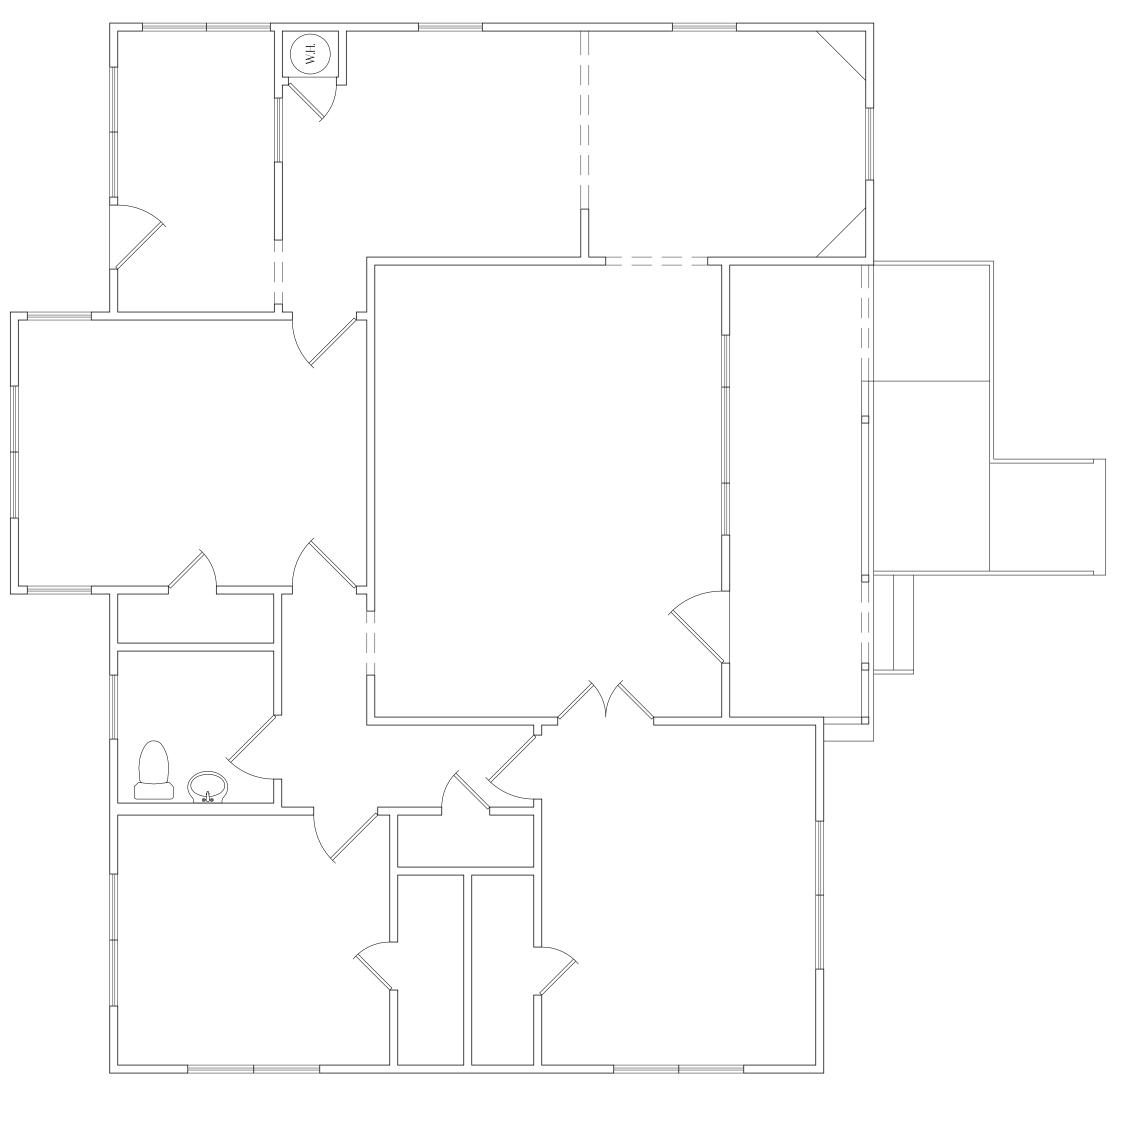

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CONSTRUCTION BY:

plans / construction drawings.

DRAWN BY:

CHECKED BY:

20037

EXISTING AREAS:

APPROXIMATE LIVING

APPROXIMATE TOTAL A.U.R.

PORCH

1,298 中

115 **中**

1,413 Ф

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