

## LEGAL DESCRIPTION:

Being all of Lot 2, Block A, Leidy Addition, an addition in the City of Keller, Tarrant County, Texas, according to the plat thereof recorded under Instrument Number 12217080368 of the Official Public Records of Tarrant County, Texas.

## TITLE COMMITMENT NOTES:

This survey was performed with the benefit of a commitment for title insurance provided by Capital Title/McGee Law Firm, File # 17-294512-RS, effective March 2, 2017, and issued March 14, 2017. Complete copies of the record description of the property, any record easements benefiting the property, the record easements or servitudes and covenants affecting the property ("Record Documents"), documents of record referred to in the Record Documents, and any other documents containing desired appropriate information affecting the property being surveyed and to which the survey shall make reference were not provided to this surveyor for notation on the survey except for those items listed within Schedule B of said commitment. Therefore, easements, agreements, or other documents, either recorded, or unrecorded may exist that affect the subject property that are not shown on this survey.

- 1. The easement created under Instrument No. D207203375, O.P.R.T.C.T., is not shown on this survey, it is not on and does not touch the surveyed property.
- The building lines shown and easements dedicated on the plat recorded under Instrument No. D217080368, O.P.R.T.C.T., are shown on this survey.

## SURVEYOR'S NOTE:

Registered Professional Land Surveyor No. 5754

jewel@jphls.com April 24, 2017

The field work was completed April 13, 2017

## PLAT NOTES FROM LEIDY ADDITION, INST.# D217080368, O.P.R.T.C.T.:

- 1. Selling a portion of any lot within this addition by metes and bounds is a violation of state law and city ordinance and is subject to fines and withholding of utilities and building permits
- 2. All setbacks shall be in accordance with the zoning district, as described in the Keller Unified Development Code.
- 3. According to the Zoning Map of the City of Keller, subject tract lies in "SF-36" zoning
- 4. Lot 3, Block A must comply with the 2009 International Fire Code as amended and adopted, before the issuance of a building permit, and the installation of a fire sprinkler system and separate water meter is required, regardless of the size of the home.
- Lot 2 Block A if the current residence is demolished and re-built or a building addition inco 6,000 square feet or greater, the installation of residential fire sprinklers shall be required.
- 6. Residential fire sprinkler systems require a separate tap and meter for water supply.
- 7. This subdivision is subject to all of the terms and conditions of Tarrant County Commissioner Court Order Number 42703 (Sewage Regulations). Prior to the issuance of a building permit, a license must be obtained by the owner for any private sewage facility (septic tank or aerobic system) to be constructed in the subdivision. A sewage disposal plan will be filed with Tarrant County and areas suitable for septic tanks or aerobic systems will
- 8. Lots 2 & 3 shall have vehicular access (ingress/egress) to a public street and access to public utilities across Lot 1.
- 9. The Drainage Easements shown on the plat are dedicated to the City for storm water runoff control. Those The Drainage Leacements shown on the plat are coclicated to the City for storm water funoit control. Hose drainage casements covering areas to be left in a natural state will be the property owner's responsibility to keep unobstructed and maintained, including erosion control. Property Owners shall keep these natural drainage ways on their property mowed, clean, and free of debris, silt, or other substances which would result in unsanitary conditions. The City of Keller shall have the right to enter all drainage casement areas for the purpose of conditions. The City of Keller shall have the right to enter int training easement areas for ine purpose of inspecting the drainage ways for confirmation of condition of the drainage way with respect to maintenance and erosion control. The City of Keller will not be responsible for the maintenance or erosion control of the open channel area within the drainage easement which is left in the natural state. The open channel areas left in the natural state are occasionally subject to storm water overflow and bank crossion that cannot be predetermined. The City of Keller shall not be liable for any damages resulting from the occurrences of this overflow and crossion. No construction, modifications, or fencing will be allowed in the drainage easement without the written approval of the City of Keller's Director of Public Works.





BY: .....

## VICINITY MAP

BANCROFT ROAD SANTA CRUZ DR

LAND TITLE SURVEY LOT 2, BLOCK A LEIDY ADDITION INST:# D217080368, O.P.R.T.C.T.
CITY OF KELLER, TARRANT COUNTY, TEXAS

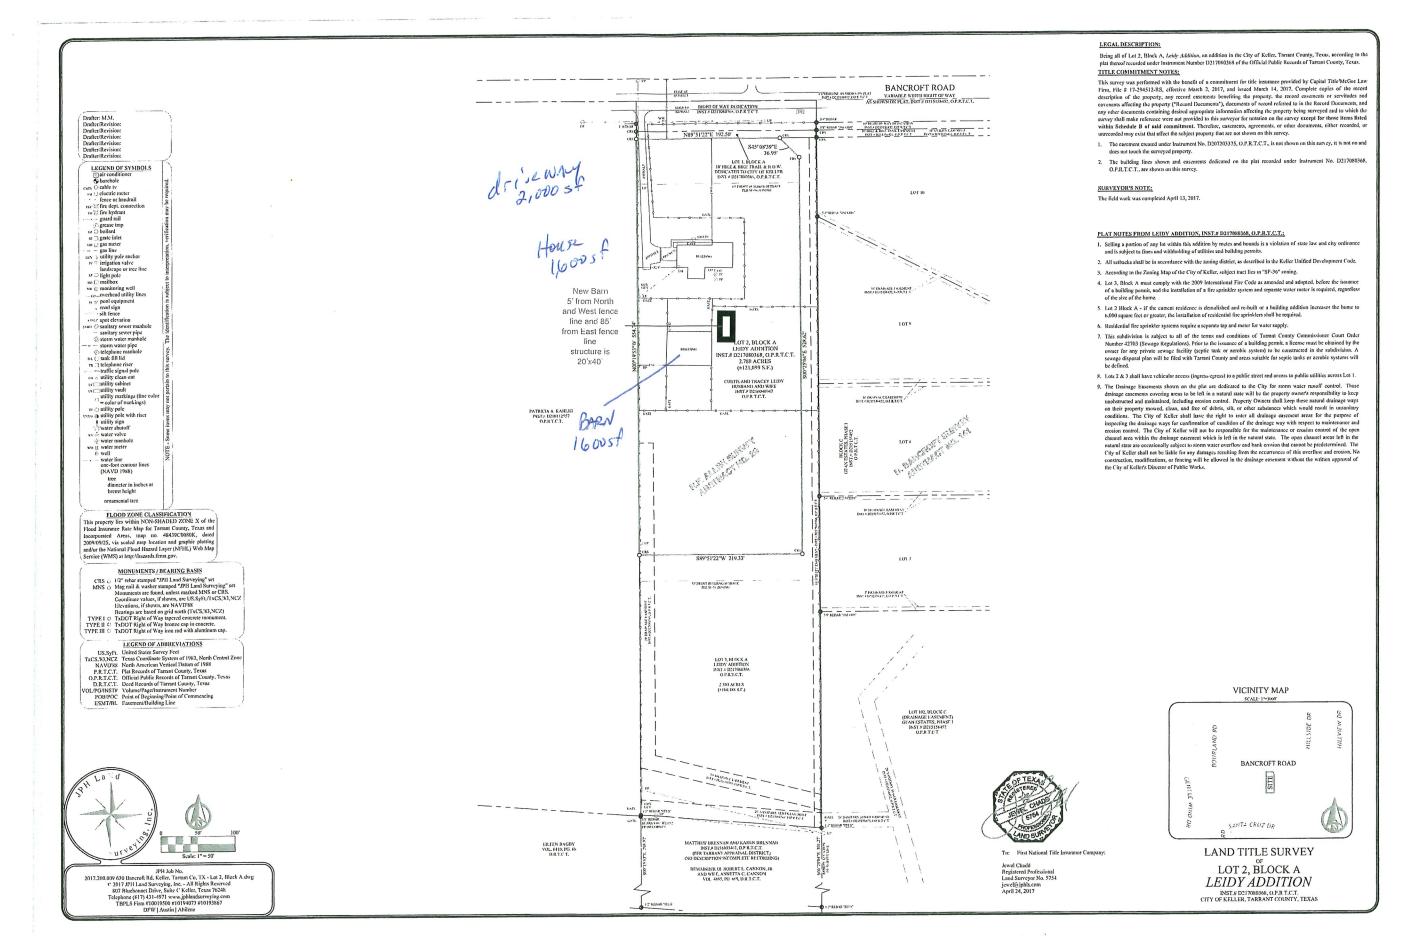


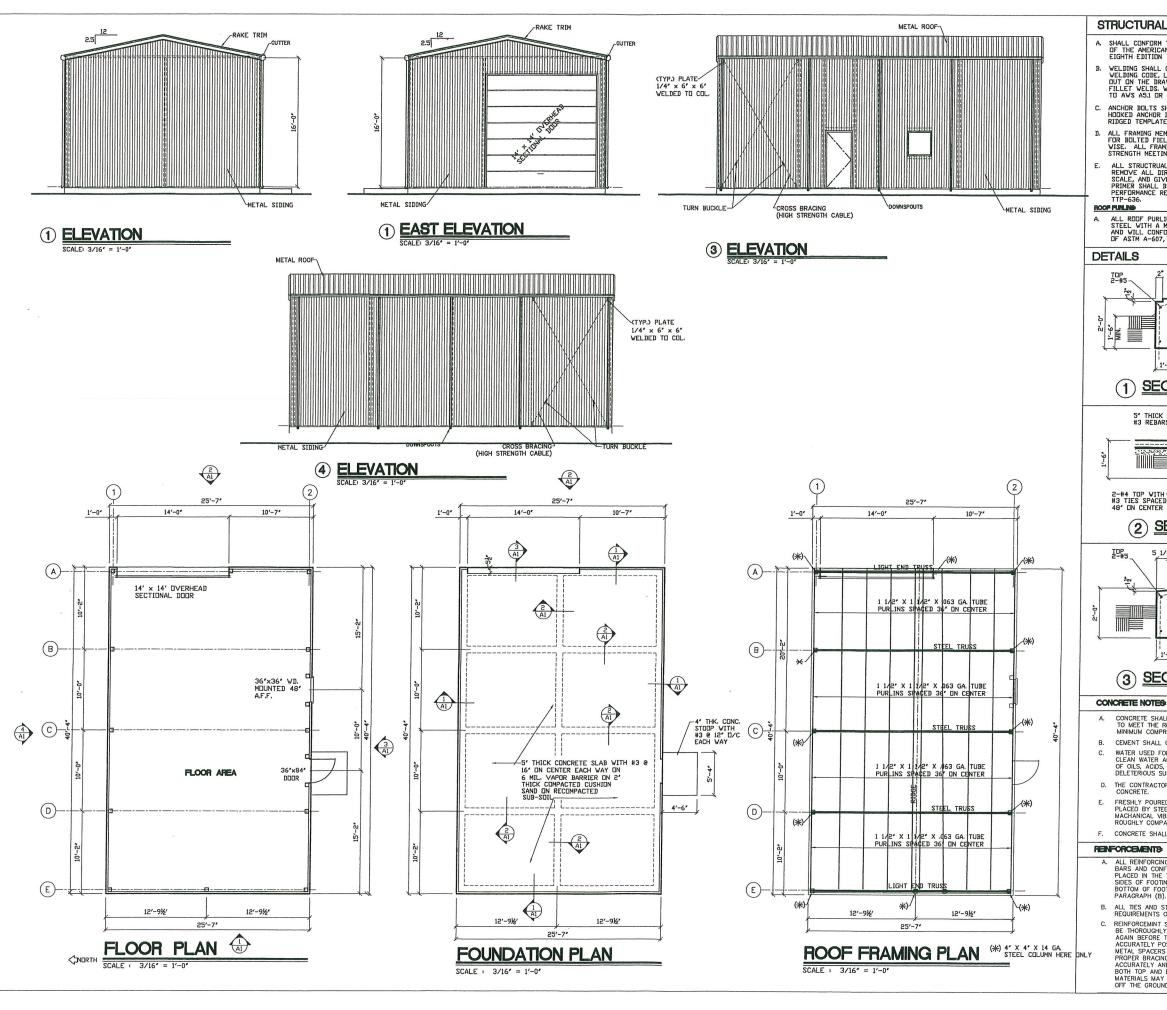


## STRUCTURAL STEEL NOTES

- A. SHALL CONFORM TO ASTM A-36 AND THE STANDARDS OF THE AMERICAN INSTITUTE OF STEEL CONSTRUCTION EIGHTH EDITION
- B. VELDING SHALL CONFORM TO AVS DL1, STRUCTURAL VELDING CODE, LATEST EDITION. VELDING COLLED OUT ON THE DRAVING SHALL BE 3/16" MIN CONTINOUS FILLET VELDS. VELDING ELECTRODES SHALL CONFORM TO AVS ASI OR ASS E70XX.
- C. ANCHUR BULTS SHALL CONFORM TO ASTM A-36 FOR HODIKED ANCHUR BULTS, AND SHALL BE SET WITH RIDGED TEMPLATES.
- D. ALL FRAMING MEMBERS SHALL BE SHOP-FABRICATED FOR BOLITED FIELD ASSEMBLY, UNLESS NOTED DITHER-VISE. ALL FRAMING MEMBER BOLTS SHALL BE HIGH STRENGTH MEETING ASTM A-307 OR A-325.
- ALL STRUCTRUAL MEMBERS SHLL BE CLEANED TO REMOVE ALL DIRT, GREASE, DIL AND LODSE MILL SCALE, AND GIVEN DUE SHOP COLT OF PRIMER PAINT, PRIMER SHALL BE EQUAL TO OR EXCEED THE END PERFORMANCE REQUIREMENTS OF FEDERAL SPEC.


ALL ROOF PURLINS SHALL BE COLD FORMED FROM STEEL WITH A MINUMUM YIELD STRENGTH OF 50 KSI AND WILL CONFERN TO THE PHYSICAL SPECIFICATIONS OF ASTM A-607, GRADE 50.

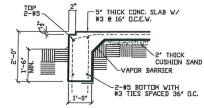

# 1 SECTION

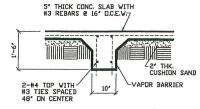

# 2 SECTION

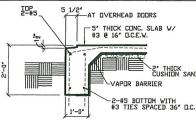

# 3 SECTION

- CONCRETE SHALL BE PORTLAND CEMENT OR EQUAL TO MEET THE REQUIRED 3,000 P.S.I. AT 28TH DAY MINIMUM COMPRESSIVE STRENGTH, 5 SACKS OF MIX.
- CEMENT SHALL CONFORM TO ASTM-C150, TYPE I.
- WATER USED FOR CONCRETE SHALL BE MIXED WITH CLEAN WATER AND FREE FROM INJURIOUS AMOUNTS OF OILS, ACIDS, ALKALINES, ORGANIC OR OTHER DELETERIOUS SUBSTANCES.
- D. THE CONTRACTOR SHALL USE READY MIXED CONCRETE.
- FRESHLY POURED CONCRETE SHALL BE TAMPED INTO PLACED BY STEEL RAMMER, SUCING TOOLS OR MACHANICAL VIBRATORS, UNTIL CONCRETE IS THOROUGHLY COMPACT AND WITHOUT VOID.
- F. CONCRETE SHALL HAVE A SLUMP RANGE OF 4" TO 5".

## REINFORCEMENTS:

- A. ALL REINFORGING STEEL SHALL BE DEFORM TYPE BARS AND CONFORM TO ASTM—A 615, GRADE 60, PLACED IN THE TOP 1 1/2" OF SLAB. 1 1/2" ON BOTH SIDES OF FOOTING AND THREE (3) INCHES FROM BOTTOM OF FOOTING, EXCEPT OTHERWISE NOTED IN PARAGRAPH (B).
- B. ALL TIES AND STIRRUPS SHALL CONFORM TO THE REQUIREMENTS OF ASTM-A 615, GRADE 40.
- REQUIREMENTS OF ASTM—A 615, GRADE 40.

  REINFORCEMINT STEEL, BARS AND WIRE FABRIC SHALL BE THOROUGHLY CLEANED BEFORE PLACING AND AGAIN BEFORE THE CONCRETE IS PLACED, SHALL BE ACCURATELY POSITIONED AND SECURED IN PLACE, METAL SPACERS SHALL BE USED TO SECURE THE PROPER BRACING OF THE STEEL STIRRUPS SHALL BE ACCURATELY AND SECURELY WIRED TO BARS ATT BOTH TOP AND BOTTOM. NO BRICK OR POROUS MATERIALS MAY BE USED TO SUPPORT THE STEEL OFF THE GROUND

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4			

ENGINEERING and ASSOCIATES
5 STAIR ROAD, SUITE 201
RORTH, TEXAS 76112
16.1364 / FAX: 817.446.1307 104 OAK TRAIL INDON, TEXAS 76028 (817) 446-1364 REGISTRATION NO. F-1 M. FAGGETT

JOHN TAYLOR a 6800 BRENTWOOD ST FORT WORTH OFFICE: 817.446.11

PROPOSED METAL BUILDING
JENNIFER CLARK
40' METAL BUILDING
630 BANGROT ROAD
KELLER, TEXAS 78248 AND CON ON BLVD. 76028 CONTRACTOF
BUILDING
NORTH BURLESC
LESON, TEXAS
817-295-6022 METAL 415 BUR  $\times$ 25

JOB NO.	2019
DRAWN BY	JET
CHECK BY:	JET/EF
DATE	4/29/2019

## SHEET TITLE

FLOOR PLAN


■ FOUNDATION PLAN / DETAILS

ROOF FRAMING PLAN




SHEET NO.

OF 2

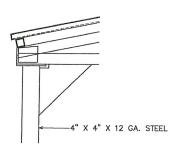

2 DETAIL SCALE: NOT TO SCALE

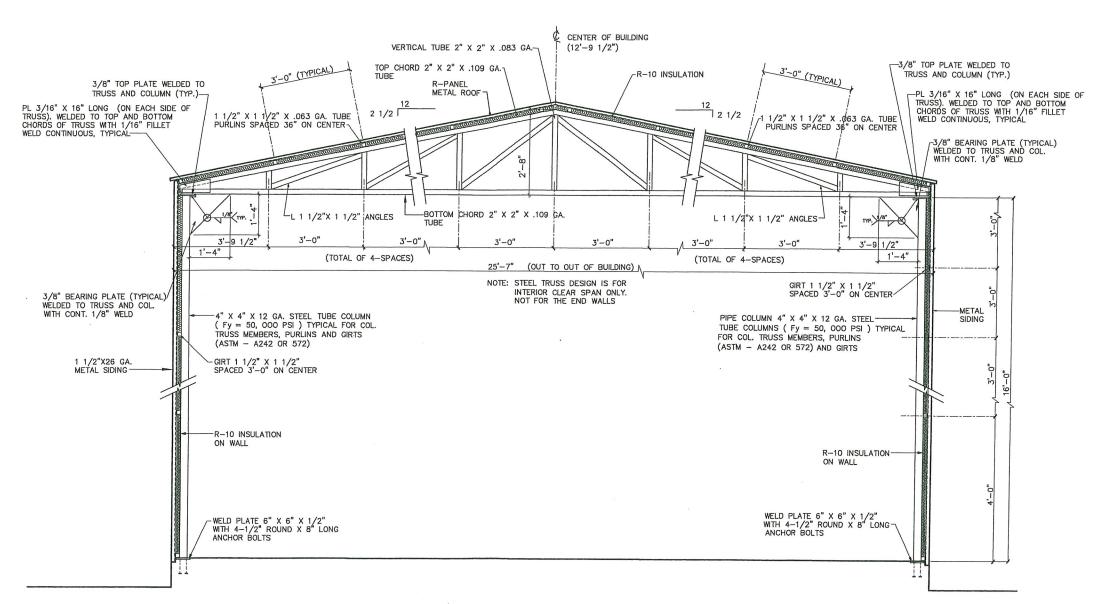

1 TYPICAL TRUSS WALL SECTION
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$\Box$	DATE	RESPONSE
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E. M. FAGGETT ENGINEERING
104 OAK TRAIL
RENOW, TEXS 78028
FIRM REGISTRATION NO. F-11761

JOHN TAYLOR and ASSOCIATES
6800 BRENTWOOD STAIR ROAD, SUITE 201
FORT WORTH, TEXAS 76112
OFFICE: 817.446.1307
E-MAIL: toyor7677@aboglobalnet

CONTRACTOR
MILLER'S METAL BUILDING AND CONST., INC.
415 NORTH BUILESON BLVD.
BURESON, TEXAS 76028
817-285-6022
PROPOSED METAL BUILDING
JENNIFER CLARK
25' X 40' METAL BUILDING
KELLER, TEXAS 78248
KELLER, TEXAS 78248

JOB NO.	2019
DRAWN BY	JET
CHECK BY:	JET/EF
DATE	4/29/2019

SHEET TITLE:

WALL SECTION



\ 0 (

OF 2

# JOHN TAYLOR & ASSOCIATES

6800 BRENTWOOD STAIR ROAD, SUITE 201 FORT WORTH, TEXAS 76112 (817) 446-1364 Office (817) 446-1307 Fax

May 10, 2019

City of Keller, Texas Attn: Planning & Development Department 1100 Bear Creek Parkway Keller, Texas 76248

Re: Metal Building Jennifer Clark, owner 630 Bancroft Road Keller, Texas 76248

Attn: Planning Department:

In referenced to the above building project, it was designed and engineered slab to meet the 2015 (IBC) International Building Code.

If you have any questions, please call me at (817) 446-1364 or email me at taylor7677@sbcglobal.net

Sincerely,

John Taylor, Designer JET

JEI

Project Engineer: Edward Faggett, PE #37209

Edward Faggett

